

Appendix B.11 Landscape Design Plan

PROPOSED KALFRESH 6206 CUNNINGHAM HIGHWAY, KALBAR Landscape Works Package

Prepared

By

For





SITE LOCATION PLAN



TAKEN FROM NEARMAP DATED: 27/11/23

SCHEDULES

DRAWING SCHEDULE

| DWG NO | DRAWING TITLE | ISSUE |
|--------|--|-------|
| 000 | COVER SHEET | F |
| 001 | LANDSCAPE NOTES | F |
| 002 | PLANTING SCHEDULE | F |
| 003 | PLANTING IMAGES | F |
| 100 | MASTER PLAN | F |
| 101 | LANDSCAPE PLAN (CUNNINGHAM HIGHWAY FRONTAGE) | F |
| 102 | LANDSCAPE PLAN (OVERLAND FLOW PATH) | F |
| 103 | LANDSCAPE PLAN (HAULAGE ROUTE FRONTAGE) | F |
| 104 | LANDSCAPE PLAN (PRIMARY FRONTAGE) | F |
| 200 | PERSPECTIVES (FRONTAGE TYPES) | F |
| 300 | BUFFER LANDSCAPE PLAN | F |
| 400 | STREET LANDSCAPE PLAN | F |
| 401 | STREET LANDSCAPE PLAN | F |
| 402 | STREET LANDSCAPE TYPICAL SECTIONS | F |
| 500 | LANDSCAPE DETAILS | F |
| | | |



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16/01/24 19/12/23

SUBMISSION TO SCRC AMENDMENTS AS REQUIRED AMENDMENTS AS REQUIRED AMENDMENTS AS REQUIRED DRAFT FOR REVIEW

THIS DRAWING HAS BEEN PREPARED WITH ALL CARE FROM BASE INFORMATION AVAILABLE AT THE TIME OF PREPARATION. ALL EXISTING AND RETAINED ELEMENTS ARE SHOWN INDICATIVELY ONLY. THE LOCATION OF THESE ELEMENTS ARE BASED FROM SURVEY INFORMATION. ALL PLANS AND DETAILS ARE TO BE READ IN CONJUNCTION WITH ALL RELEVANT CONSULTANT'S DOCUMENTATION PACKAGES, INCLUDING (BUT NOT LIMITED TO) ARCHITECTURAL, CIVIL, STRUCTURAL, HYDRAULIC, ELECTRICAL, LIGHTING AND SIGNAGE DOCUMENTATION. ALL ABOVE AND BELOW GROUND SERVICE LOCATIONS ARE SHOWN INDICATIVELY. REFER TO THE RELEVANT ENGINEERS DRAWINGS AS REQUIRED. ALL DIMENSIONS ARE TO BE VERIFIED ON SITE.

PROPOSED KALFRESH 6206 CUNNINGHAM HIGHWAY, KALBAR **COVER SHEET**

JOB No. DWG No. ISSUE DRAWN BY CHECKED BY 23.274 **000** F

LANDSCAPE NOTES

GENERAL NOTES

A. ARCHITECTURAL WORKS INFORMATION

Refer to Architect's drawings for all information contained within these documents related to and nominated as Architectural Works. This includes all hardscape items such as paving, outdoor structures / shelters, walls and fencing. Architectural Works information contained within these documents are indicative only and not for construction or certification purposes.

B. CIVIL WORKS INFORMATION

Refer to Civil Engineer's drawings for all information contained within these documents related to and nominated as Civil Works. Civil Works information contained within these documents are indicative only and not for construction or certification purposes.

C. STRUCTURAL WORKS INFORMATION

Refer to Structural Engineer's drawings for all information contained within these documents related to and nominated as Structural Works. This includes retaining walls. Structural Works information contained within these documents are indicative only and not for construction or certification purposes.

D. ELECTRICAL WORKS INFORMATION

Refer to Electrical Engineer's drawings for all information contained within these documents related to and nominated as Electrical Works. Electrical Works information contained within these documents are indicative and not for construction or certification purposes.

E. HYDRAULIC WORKS INFORMATION

Refer to Hydraulic Engineer's drawings for all information contained within these documents related to and nominated as Hydraulic Works. Hydraulic Works information contained within these documents are indicative only and not for construction or certification purposes.

LANDSCAPE SPECIFICATION NOTES

LEVELS - GENERAL NOTES

When setting out lines and levels ensure the accurate formation of grades and crossfalls leading to drains to enable surplus water to reach the drainage system and to prevent potential erosion channels. Ponding is

Minimum crossfalls are as follows: Paving and artificial grass 1:75

Grassed and mulched garden areas 1:50

Maximum crossfalls are as follows:

Paving 1:40

 Grassed areas 1:5 Mulched garden areas 1:3

Finish organic mulch surfaces adjacent paving surfaces and / or edging. Finish lawn surfaces flush with adjacent paving surfaces and / or edging. Ensure adequate falls in finished surface levels away from buildings to drainage collection points (eg, field inlets, etc).

SUBSOIL DRAINAGE - GENERAL NOTES

Ensure adequate subsoil drainage elsewhere by installing suitable agricultural drainage systems where necessary, and especially in areas subjected to site excavation works including retaining walls.

Lay subsoil drains in: -

- Garden beds that are adjacent to buildings surrounded on all sides by pavements or in any garden
- beds where water is likely to pond;
- In any grassed areas where water is likely to sit and be unable to disperse quickly
- Behind retaining walls and raised kerbs In locations as shown on the drawings

Unless otherwise specified, all subsoil drains shall be corrugated, 90mm slotted PVC contour pipe, wrapped in Bidum V14 filter cloth or equal equivalent. Filter gravel to be 10mm clean washed aggregate. Lay drainpipe in

continuous lengths where possible with minimum 1:100 falls. Discharge pipes into stormwater system.

Where grades are not sufficient to carry water out of the landscape area adequately and safely, supply and install drainage sump/ to catch excess water.

Sumps are to be fitted with a heelguard no-slip grate and connected to the stormwater system. Refer to Hydraulic and Civil Engineer's drawings for drainage pit specifications and connections.

<u>PLANTS</u>

- NATSPEC shall apply to trees where Council requires this certification.
- Trees must meet AS 2303:2018 Tree Stock for Landscape Use
- Plants are to be good quality nursery stock from a NIASA Accredited nursery · They shall be fundamentally free of pest and diseases, vigorous, well established, hardened off, of good form consistent with species or variety, not soft or forced with large healthy root systems with no evidence of
- having been restricted or damaged. Trees shall have a single leading shoot. • Provide plants of a height and spread appropriate to the specified pot size and species.
- Mature tree stock shall be properly prepared for transport with adequate measures taken to protect against
- shock and wind damage. • Ensure sequencing with site foreman to avoid delays planting mature tree stock.
- After installation they shall be thoroughly watered.
- Trees to be single-trunked canopy shade tree species able to attain a clear trunk height of 1800mm on maturity.

SUBGRADE PREPARATION:

Turfed areas shall be prepared initially by removing all deleterious material Cultivate subgrade surface by thoroughly ripping to a minimum depth of 150mm before spreading topsoil unless

otherwise directed (ie: no cultivation under trees to be retained)

Spread turf underlay topsoil to a minimum depth of 100mm unless otherwise directed. Proposed topsoil must comply with Australian Standards AS4419-2003 and described as 'Soil blend'.

- To be fundamentally free from weeds and disease or other deleterious substances.
- New Road Reserves: Use "Wintergreen" Overland Flow Area: Use "Sir Walter"

INSTALLATION:

- Turf shall be close turfed with staggered cross-joints and laid in straight lines, running perpendicular to the direction of slope (and/or parallel to contours).
- Proposed topdressing soil to comply with Australian Standards AS4419-2003 and as described as
- All joints shall be filled with an approved topdress light soil or sand and the turf shall be lightly rolled.
- Finished levels shall be 3mm below surrounding surface levels to allow for future top dressing. Allowance
- should be made for shrinkage and settling. Turf shall be adequately watered once installed, refer Management Plan/s. Ensure protection from trampling. Lay turf within 36 hours of being cut.

- FERTILISER: Fertiliser to be applied to the turf at the rates and period of time from installation as recommended by the supplier. If no starter Fertiliser supplied by the supplier, we recommend:
- Dynamic Lifter Turf Starter: $\underline{\text{http://www.yates.com.au/products/fertilising/organic-based/dynamic-lifter-turf-starter/\#tbCQXOZuFJZ01z1B.97}$
- Lawn Builder™ Seed & Turf Starter Slow Release Lawn Fertiliser: https://www.scottsaustralia.com.au/scotts-brands/lawn-builder/lawn-builder-slow-release-

lawn-fertilisers/lawn-builder-seed-turf-starter-slow-release-lawn-fertiliser/

SOIL WETTING AGENT: We recommend the application of a soil wetting agent wetting agent (ie: non biodegradable detergent not crystals) to stop hydrophobia if not already in the starter fertiliser supplied with the turf, at the rates recommended by the manufacturer:

- Scotts Hydraflow Wetta Soil Searle's Penetraide
- · Plant of Health Soils Soaker

WEEDS, PESTS DISEASE MANAGEMENT:

Weeds are required to be removed by physical or chemical (non-residual Glyphosate or other herbicides) means. If chemical means, as per the manufacturer recommendations. Refer to the following reference for guideline on weeds, pest and disease management

REFERENCE: http://thelawnguide.com.au

PLANTING BEDS

SUBGRADE PREPARATION: Cultivate subgrade surface by thoroughly ripping to a minimum depth of 150mm before spreading topsoil.

Spread topsoil to a minimum depth of 300mm unless otherwise directed. Proposed topsoil must comply with Australian Standards AS4419-2003 and described as 'Soil blend'. Provide certification of soil types delivered to site, as per AS4419-2003.

Mature tree stock shall be properly prepared for transport with adequate measures taken to protect against shock and wind damage. Ensure sequencing with site foreman to avoid delays planting mature tree stock.

A slow or controlled release fertiliser organic or inorganic to be incorporated generally into the imported (or

FERTILIZER: Ensure soil nutrient and PH levels are suitable for specific plant species (ie. native or exotic species) Apply slow release fertilizer to each plant as per manufacturer's recommended rates.

Inorganic Slow or Controlled Release fertilisers:

excavated / site topsoil). We recommend the following:

- Osmocote
- Nutricote Macrocote
- E-Scape PRO by eCo-Environment

Organic slow release: Dynamic Lifter

Organic Link by Plant of Health

WETTING AGENT:

A wetting agent and / or soil ameliorant including a wetting agent is required to all mass planting beds:

Scotts Hydraflow Wetta Soil

Multipro by eCo-Enviroment

Searle's Penetraide Plant of Health Soils Soaker

PLANTING:

To locations as shown on the plan and to the sizes and numbers as shown on the schedule.

Rake smooth to finish flush with surround levels. Do not place in contact with stems of plants.

ORGANIC MULCHING:

Proposed mulch must comply with Australian Standards AS4454-2003. 'Composts, soil conditioners and mulches'. Spread an even cover of Aged double tub ground forest mulch to a minimum depth of 100mm entirely over planting bed areas where organic mulch is specified.

Any mulch used must be free of peanut shell or other irritant material.

Install to the locations as per the details.

SPADE CUT GARDEN EDGE

Planting plan has been designed to survive without an automatic irrigation system. Water additives and water retention elements, along with hardy water-wise plants will ensure an irrigation system is not imperative to the long-term maturation and survival of the proposed plants. If approved, install an automatic, fixed position, low pressure sprinkler irrigation system to all landscaped areas shown on the drawings internal to the site only, to Scenic Rim Regional Council approval. The irrigation shall meet the following performance requirements and as

- per the manufacturers and/or installers specifications: Summer target application of 32mm
- Fully automatic and metered
- Recycled water use (from rainwater tanks)
- Commercial quality fittings and fixtures Mainlines
- Dripline system under mulch RPZ backflow prevention device

All design and documentation, materials supplied and work carried out should be in accordance with the current relevant Australian Standards and best practice.

GENERAL NOTES:

- All materials and worksmanship shall be to the relevant Australian Standards.
- Where pipe work shown running parallel under paved surfaces, has been done so for clarity purposed only.
- · All pipe work is to be installed within soft landscaped areas only where possible.
- Pipe hops over mainlines not shown. All connections to mainlines only to solenoid valve locations. Contractor shall undertake the radius adjustment of all rotor sprinklers as required.
- For all sprinkler heads to back of road kerbs, water supply lateral to be installed minimum of 500mm off back of kerb.
- All pipe work under concrete paving to be installed in sleeves.
- All pipe work under removable paving may be pre-laid prior to paving works. • All pipe work under retained area to be pre-laid prior to retaining wall construction.
- Irrigation mainline alignments in verges to be in standard alignment zone for trees i.e. 2.5m to 3m from property boundary, unless otherwise noted.
- Cross-stacking of pipe fittings is not allowed. Lateral pipe work routed parallel to mainlines shall not be installed directly above mainlines. Laterals must be
- horizontally offset by a minimum of 300mm from mainlines. All pipe work shall be routed around any existing trees and no closer than tree canopy 'drip line'. All tree roots smaller than 50mm diameter which are damaged during excavation shall be cleanly cut with a saw or
- secateurs. Any tree roots 50mm or greater encountered are not to be damaged and pipe trench shall be hand-excavated, thrust bored (plunked) or air-drilled (either pressure and/or suction). • A minimum length of 200mm of pipe shall be provided between fittings in lateral pipe work.

Please note that this drawing is to be read in conjunction with the detail drawing and the specifications. WATER BUDGET AND CONSUMPTION NOTES

- Irrigation area is for current project works stage only and is approximate. The area has been calculated from
- the valve data able as a function of flow rate and nominal precipitation rate. Operator to be aware of any water usage restrictions which may be applicable, such as total exclusion
- periods (e.g. June to August inclusive) and/or restrictions on the number of cycles per week (e.g. groundwater - 3 cycles per week, potable scheme water - 2 cycles per week).

PLANT ESTABLISHMENT / CONTINUING MAINTENANCE

Allow a 12 WEEK for landscape areas and 12 MONTH for Streetscape for Plant Establishment Period from Practical Completion to the satisfaction of the Landscape Architect.

- Maintain adequate watering regime
- Remove weed growth from all mass planting beds and turfed areas Keep landscape areas tidy and free of litter and debris
- Fertilise (as per the notes above) Weed control (as per the notes above)
- Prune planting, control pest and disease management (as per the notes above) to maintain healthy growth Replenish mulch material where necessary
- Replace dead / dying plant material Reinstate stakes, ties and marker stakes where necessary
- Reinstate erosion control matting and other erosion control measures as necessary Make good any disturbance to surfaces and mulch

Continue maintenance works beyond Plant Establishment Period as required.

of 5l/m², including natural rainfall, or as required to maintain active healthy growth.

MANAGEMENT PLAN/S: The turfed areas shall be throughly watered on the day of turf installation and then as follows at the equivalent

Weeks 1-3: Twice a week

Weeks 3-12: Once a week or as necessary If no irrigation, apply the above rates to the mass planting beds. Watering to use rainwater tanks if possible.

SPECIAL NOTE

Accord particular diligence to the following prime items:

TOPSOIL QUALITY and SUBGRADE PREPARATION as specified.

PLANT QUANTITY: Use only consistently well nurtured nursery stock from an approved supplier. Check with Landscape Architect where species substitutions must be made.

MAINTENANCE: Ensure a continuing maintenance program, including weed/disease, fertilising, watering (but beware of over-watering) and replacement of ailing plant material.

Failure to adequately address these items, best practice and relevant Australian Standards WILL result in a sub-standard landscape outcome.



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FINAL - FOR APPROVAL 07/02/24 19/01/24 SUBMISSION TO SCRC AMENDMENTS AS REQUIRED 18/01/24 16/01/24 AMENDMENTS AS REQUIRED 19/12/23 AMENDMENTS AS REQUIRED 08/12/23 DRAFT FOR REVIEW

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PROPOSED KALFRESH 6206 CUNNINGHAM HIGHWAY, KALBAR LANDSCAPE NOTES

JOB No. DWG No. ISSUE DRAWN BY CHECKED BY 23.274 **001** F

PLANTING SCHEDULE

The spacing of plants shown on plan have been derived as a compromise between growth rate, anticipated size, and the ability to provide a good vegetative cover within a reasonable space of time. Quantities indicated have been based on the spacing of individual plants appropriate to the available area for the particular species used; where this available area increases (or decreases) through the course of construction, quantities may also need to increase (or decrease) to maintain the plant

AGLA recommends early plant procurement to ensure species availability and minimum plant sizes.

| | BOTANICAL NAME | COMMON NAME | SIZE** | QUANTITY PER UNIT | SPACING | HEIGHT* | WIDTH* |
|--|--|--|--|---|---|---|---|
| As informed by | ANDSCAPE - BUFFER TO CUNNINGHAM HIGH y Scenic Rim Planning Scheme's 'Preferred Landscape Specie This could be a series of the | s' within Planning Scheme Policy 2: Landscape De | | Trees, Table 22.3(a) Landscape | Trees, Table 22.3(b) Landsc | ape Tree Species - 3 to | 5 metres, |
| Table 22.3(c) I LARGE TR | Landscape Dwarf Shrubs - 1 to 1.5 metres, Table 22.3(d) Grou | ndcovers, and Table 22.3(e) Clumping Bulbs, Lillie | es and Grasses | | | | |
| | | | | _ | | | |
| Bp Lc | Brachychiton populneus Lophostemon confertus | Kurrajong Brush Box | 300mm 300mm | 2 1 | 13-18 13-18 | 20 20 | 8 10 |
| Pe | Podocarpus elatus | Brown Pine | 300mm | 1 | 13-18 | 20 | 8 |
| MEDIUM T | REES | | | | | | |
| Зс | Buckinghamia celsissima | Ivory Curl | 300mm | 3 | 5-8 | 12 | 5 |
| Er . | Elaeocarpus reticulatus | Blueberry Ash | 300mm | 2 | 5-8 | 12 | 5 |
| Sa Xc | Syzygium australe Xanthostemon chrysanthus | Lillypilly Golden Penda | 300mm 300mm | 3 3 | 5-8 5-8 | 8 12 | 6 8 |
| | ŕ | Golden Fenda | 30011111 | J | 3-0 | 12 | Ü |
| ARGE SH | RUBS | | | | | | |
| CAL WW | Callistemon viminalis Wilderness White | Bottlebrush | 200mm | 12 | 2 | 3 | 2 |
| GRE M MEL lin | Grevillea Moonlight Melaleuca linariifolia Snow in Summer | Grevillea Bottlebrush | 200mm 200mm | 6 6 | 3 2 | 5 6 | 4 3 |
| SYZ res | Syzygium australe Resilience | Lillypilly | 200mm | 6 | 2 | 5 | 3 |
| ROUNDC | OVERS TO SHRUBS | | | | | | |
| .OM hys | Lomandra hystrix | Mat Rush | TS | 54 | 1.2 | 1.8 | 1.5 |
| MEL S | Melaleuca linariifolia Snowstorm | Snowstorm Paperbark | 140mm | 18 | 1.2 | 1.5 | 1.5 |
| NES fru | Westringia fruticosa | Native Rosemary | 140mm | 24 | 1.2 | 2 | 1.5 |
| SCREENI | ANDSCAPE - OVERLAND FLOW PATH | | | | | | |
| As informed by Γable 22.3(c) I | y Scenic Rim Planning Scheme's 'Preferred Landscape Specie Landscape Dwarf Shrubs - 1 to 1.5 metres, Table 22.3(d) Grou | | | Trees, Table 22.3(a) Landscape | Trees, Table 22.3(b) Landsc | ape Tree Species - 3 to | 5 metres, |
| ARGE TR | | | | | | | |
| 3p .c | Brachychiton populneus Lophostemon confertus | Kurrajong Brush Box | 300mm 300mm | 1 2 | 13-18 13-18 | 20 20 | 8 10 |
| Лq | Melaleuca quinquenervia | Broad-Leaved Paperbark | 300mm | 1 | 13-18 | 15 | 8 |
| MEDIUM TI | REES | | | | | | |
| | | | 000 | 0 | 5.0 | 40 | _ |
| Bc Er | Buckinghamia celsissima Elaeocarpus reticulatus | Ivory Curl Blueberry Ash | 300mm 300mm | 3 2 | 5-8 5-8 | 12 12 | 5 5 |
| Sa | Syzygium australe | Lillypilly | 300mm | 3 | 5-8 | 8 | 6 |
| (c | Xanthostemon chrysanthus | Golden Penda | 300mm | 3 | 5-8 | 12 | 8 |
| ARGE SH | RUBS | | | | | | |
| CAL WW GRE M | Callistemon viminalis Wilderness White Grevillea Moonlight | Bottlebrush Grevillea | 200mm 200mm | 12 6 | 2 3 | 3 5 | 2 4 |
| MEL lin | Melaleuca linariifolia Snow in Summer | Bottlebrush | 200mm | 6 | 2 | 6 | 3 |
| SYZ res | Syzygium australe Resilience | Lillypilly | 200mm | 6 | 2 | 5 | 3 |
| ROUNDC | OVERS TO SHRUBS | | | | | | |
| CAL WA | Callistemon citrinus White Anzac | Prostrate Bottlebrush | 140mm | 12 | 1.5 | 1.5 | 3 |
| .OM hys | Lomandra hystrix | Mat Rush | TS | 36 | 1.2 | 1.8 | 1.5 |
| ΛEL S ΓΗΕ tri | Melaleuca linariifolia Snowstorm Themeda triandra | Snowstorm Paperbark Kangaroo Grass | 140mm TS | 9 9 | 1.2 1 | 1.5 1.5 | 1.5 0.8 |
| NES fru | Westringia fruticosa | Native Rosemary | 140mm | 12 | 1.2 | 2 | 1.5 |
| | | | | | | | |
| AESTHETI As informed by | IC LANDSCAPE - HAULAGE ROUTE FRONTAG y Scenic Rim Planning Scheme's 'Preferred Landscape Specie Groundcovers, and Table 22.3(e) Clumping Bulbs, Lillies and C | s' within Planning Scheme Policy 2: Landscape De | esign; Table 22.1 General ገ | Trees, Table 22.3(a) Landscape | Trees, Table 22.3(c) Landsc | ape Dwarf Shrubs - 1 tc | o 1.5 metres, |
| AESTHETI As informed by Table 22.3(d) TREES | y Scenic Rim Planning Scheme's 'Preferred Landscape Specie Groundcovers, and Table 22.3(e) Clumping Bulbs, Lillies and C Elaeocarpus eumundii | s' within Planning Scheme Policy 2: Landscape Do Grasses Smooth Leaved Quandong | 45L | Trees, Table 22.3(a) Landscape | 10 | 10 | 5 |
| AESTHETI As informed by Table 22.3(d) TREES Ee | y Scenic Rim Planning Scheme's 'Preferred Landscape Specie Groundcovers, and Table 22.3(e) Clumping Bulbs, Lillies and C Elaeocarpus eumundii Hymenosporum flavum | ' within Planning Scheme Policy 2: Landscape Dorasses | | Trees, Table 22.3(a) Landscape 1 1 1 | | | |
| AESTHETI s informed by able 22.3(d) REES e | y Scenic Rim Planning Scheme's 'Preferred Landscape Specie Groundcovers, and Table 22.3(e) Clumping Bulbs, Lillies and C Elaeocarpus eumundii | s' within Planning Scheme Policy 2: Landscape Do Grasses Smooth Leaved Quandong Native Frangipani | 45L 45L | Trees, Table 22.3(a) Landscape 1 1 1 1 | 10 10 | 10 12 | 5 6 |
| AESTHETI As informed by able 22.3(d) TREES See If | y Scenic Rim Planning Scheme's 'Preferred Landscape Specie Groundcovers, and Table 22.3(e) Clumping Bulbs, Lillies and C Elaeocarpus eumundii Hymenosporum flavum Tristaniopsis laurina | s' within Planning Scheme Policy 2: Landscape Do Grasses Smooth Leaved Quandong Native Frangipani Water Gum | 45L 45L 45L | Trees, Table 22.3(a) Landscape 1 1 1 1 | 10 10 10 | 10 12 15 | 5 6 6 |
| AESTHETI As informed by Table 22.3(d) TREES THE | y Scenic Rim Planning Scheme's 'Preferred Landscape Specie Groundcovers, and Table 22.3(e) Clumping Bulbs, Lillies and C Elaeocarpus eumundii Hymenosporum flavum Tristaniopsis laurina Xanthostemon chrysanthus | s' within Planning Scheme Policy 2: Landscape Do Grasses Smooth Leaved Quandong Native Frangipani Water Gum | 45L 45L 45L | Trees, Table 22.3(a) Landscape 1 1 1 1 | 10 10 10 | 10 12 15 | 5 6 6 |
| AESTHETI sis informed by able 22.3(d) FREES THE S | y Scenic Rim Planning Scheme's 'Preferred Landscape Specie Groundcovers, and Table 22.3(e) Clumping Bulbs, Lillies and C Elaeocarpus eumundii Hymenosporum flavum Tristaniopsis laurina Xanthostemon chrysanthus COVERS TO SHRUBS Callistemon Little John Leptospermum hybrid Pink Cascade | s' within Planning Scheme Policy 2: Landscape De Grasses Smooth Leaved Quandong Native Frangipani Water Gum Golden Penda Dwarf Bottlebrush Pink Cascade | 45L 45L 45L 45L 200mm 200mm | 1 1 1 1 36 12 | 10 10 10 10 | 10 12 15 12 1 0.5 | 5 6 6 10 0.9 1.5 |
| AESTHETI As informed by able 22.3(d) FREES THE Co. GROUNDC CAL LJ EP PC OM KB | y Scenic Rim Planning Scheme's 'Preferred Landscape Specie Groundcovers, and Table 22.3(e) Clumping Bulbs, Lillies and C Elaeocarpus eumundii Hymenosporum flavum Tristaniopsis laurina Xanthostemon chrysanthus COVERS TO SHRUBS Callistemon Little John | s' within Planning Scheme Policy 2: Landscape De Grasses Smooth Leaved Quandong Native Frangipani Water Gum Golden Penda Dwarf Bottlebrush | 45L 45L 45L 45L 200mm | 1 1 1 1 | 10 10 10 10 | 10 12 15 12 | 5 6 6 10 |
| AESTHETI As informed by Fable 22.3(d) TREES Ee Hf FI Kc CAL LJ EP PC OM KB MEL CT MYO par | y Scenic Rim Planning Scheme's 'Preferred Landscape Specie Groundcovers, and Table 22.3(e) Clumping Bulbs, Lillies and C Elaeocarpus eumundii Hymenosporum flavum Tristaniopsis laurina Xanthostemon chrysanthus COVERS TO SHRUBS Callistemon Little John Leptospermum hybrid Pink Cascade Lomandra hystrix Katie Belles Melaleuca linariifolia Claret Tops Myoporum parvifolium Fine Leaf | s' within Planning Scheme Policy 2: Landscape Di Grasses Smooth Leaved Quandong Native Frangipani Water Gum Golden Penda Dwarf Bottlebrush Pink Cascade Mat Rush Claret Tops Creeping Boobialla | 45L 45L 45L 45L 200mm 200mm 140mm 200mm 200mm | 1 1 1 1 36 12 9 9 | 10 10 10 10 0.8 1 0.8 1 | 10 12 15 12 1 0.5 1.8 1.5 0.15 | 5 6 6 10 0.9 1.5 1.5 |
| AESTHETI As informed by Table 22.3(d) TREES THE | y Scenic Rim Planning Scheme's 'Preferred Landscape Specie Groundcovers, and Table 22.3(e) Clumping Bulbs, Lillies and C Elaeocarpus eumundii Hymenosporum flavum Tristaniopsis laurina Xanthostemon chrysanthus COVERS TO SHRUBS Callistemon Little John Leptospermum hybrid Pink Cascade Lomandra hystrix Katie Belles Melaleuca linariifolia Claret Tops | s' within Planning Scheme Policy 2: Landscape De Grasses Smooth Leaved Quandong Native Frangipani Water Gum Golden Penda Dwarf Bottlebrush Pink Cascade Mat Rush Claret Tops | 45L 45L 45L 45L 200mm 200mm 140mm 200mm | 1 1 1 1 36 12 9 | 10 10 10 10 | 10 12 15 12 1 0.5 1.8 1.5 | 5 6 6 10 0.9 1.5 1.5 |
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| CODE | BOTANICAL NAME | COMMON NAME | SIZE** | QUANTITY | SPACING | HEIGHT* | WIDTH* | |
|--|---|------------------------------------|--------------|-----------|----------|----------|--------|--|
| BUFFER LANDSCAPE - OVERLAND FLOW AREA As informed by Scenic Rim Planning Scheme's 'Preferred Landscape Species' within Planning Scheme Policy 2: Landscape Design; Table 22.2 Tree Species for Creek Corridors and Creek Crossings and Ecological Assessment Report by 28 South Environment TREES | | | | | | | | |
| Et | Eucalyptus tereticornis | Queensland Blue gum | 300mm | 30 | as shown | 35-50 | 25-35 | |
| STREET LANDSCAPE - NEW ROAD RESERVES As informed by Scenic Rim Planning Scheme's 'Preferred Landscape Species' within Planning Scheme Policy 2: Landscape Design; Table 22.1 General Trees STREET TREES | | | | | | | | |
| Ar Bp | Agathis robusta Brachychiton populneus | Queensland Kauri Pine Kurrajong | 100L 100L | 11 203 | 10 10 | 25 20 | 7 8 | |
| TI | Tristaniopsis laurina Luscious | Water Gum | 100L | 98 | 10 | 10 | 5 | |

*HEIGHT AND WIDTH:

Heights and widths as shown are at full maturation, indicative only and dependent on environmental and microclimatic factors

** PLANT CONTAINER SIZE:

ROOT BALL SIZES

The general rule of thumb for planting is at least twice the width of the rootball and to the same depth. The corresponding dimensions to the plant container sizes are as follows. To obtain the planting hole width, simply multiply the diameter by two.


| Plant container size | Diameter | Height |
|----------------------|----------|--------|
| 100L | 520mm | 560mm |
| 45L | 420mm | 350mm |
| 300mm | 300mm | 270mm |
| 200mm | 200mm | 190mm |
| 140mm | 140mm | 140mm |

MINIMUM STOCK SIZES

The recommended minimum plant size relative to the container size is as follows. Should the stem calliper of height of the tree relative to the container size be less than the figures shown, the tree should be rejected. Ensure minimum plant height at time of planting for the specified container stock unless otherwise agreed to by the landscape architect due to availability, species type and/or time of season.

| Root ball volume | Height (above container) | Calliper (at 300mm) | Clean trunk height |
|------------------|--------------------------|---------------------|--------------------|
| 100 litre | 2.4 metres | 50mm | 1500mm |
| 45 litre | 1.9 - 2.3 metres | 30mm - 35mm | 1200mm |

The following is a guide, final plant sizes due to availability, species, type, and/or time of season.

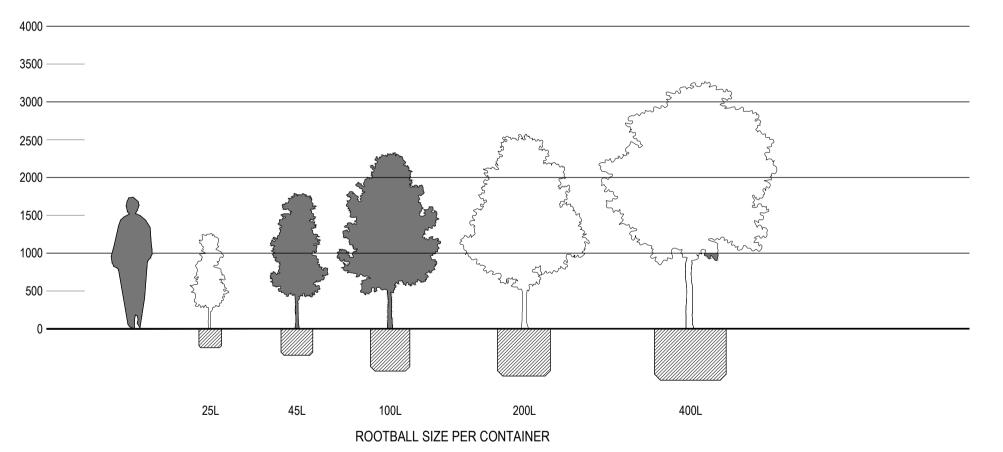

TYPICAL PLANT SIZE (ALONG WITH TYPICAL ROOTBALL SIZES) DIAGRAM SCALE 1:50 @ A1



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FINAL - FOR APPROVAL SUBMISSION TO SCRC AMENDMENTS AS REQUIRED 18/01/24 AMENDMENTS AS REQUIRED 16/01/24 AMENDMENTS AS REQUIRED DRAFT FOR REVIEW 19/12/23 08/12/23

ISSUE DATE REASON

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PROPOSED KALFRESH 6206 CUNNINGHAM HIGHWAY, KALBAR PLANTING SCHEDULE

JOB No. DWG No. ISSUE DRAWN BY CHECKED BY 23.274 **002** F

SCREEN LANDSCAPE - BUFFER TO CUNNINGHAM HIGHWAY

LARGE TREES



Kurrajong



Lophostemon confertus **Brush Box**



Podocarpus elatus **Brown Pine**

MEDIUM TREES



Buckinghamia celsissima Ivory Curl



Elaeocarpus reticulatus Blueberry Ash



Syzygium australe



Xanthostemon chrysanthus Golden Penda

LARGE SHRUBS



Callistemon viminalis Wilderness White Grevillea Moonlight





Melaleuca linariifolia Snow in Summer Syzygium australe Resilience

GROUNDCOVERS TO SHRUBS



Lomandra hystrix Mat Rush




Snowstorm Paperbark



Native Rosemary

AESTHETIC LANDSCAPE - HAULAGE ROUTE FRONTAGE AND PRIMARY FRONTAGE

TREES

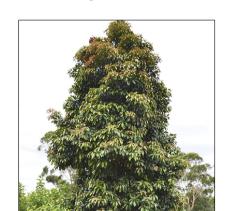

Elaeocarpus eumundii **Smooth Leaved Quandong**



Hymenosporum flavum Native Frangipani



Tristaniopsis laurina Water Gum



Xanthostemon chrysanthus Golden Penda

GROUNDCOVERS TO SHRUBS



Callistemon Little John **Dwarf Bottlebrush**



Leptospermum hybrid Pink Cascade Pink Cascade



Lomandra hystrix Katie Belles Mat Rush



Melaleuca linariifolia Claret Tops



Myoporum parvifolium Fine Leaf Creeping Boobialla



Dwarf Rosemary

SCREEN LANDSCAPE - BUFFER TO OVERLAND FLOW PATH

LARGE TREES



Kurrajong



Lophostemon confertus **Brush Box**



Melaleuca quinquenervia Broad-Leaved Paperbark

MEDIUM TREES



Buckinghamia celsissima Ivory Curl

LARGE SHRUBS



Elaeocarpus reticulatus Blueberry Ash



Syzygium australe



Xanthostemon chrysanthus Golden Penda



Melaleuca linariifolia Snow in Summer Syzygium australe Resilience



GROUNDCOVERS TO SHRUBS

Callistemon viminalis Wilderness White Grevillea Moonlight



Prostrate Bottlebrush



Lomandra hystrix Mat Rush



Snowstorm Paperbark



Themeda triandra Kangaroo Grass



Westringia fruticosa Native Rosemary

STREET LANDSCAPE - NEW ROAD RESERVES

BUFFER LANDSCAPE -OVERLAND FLOW AREA

TREES



Eucalyptus tereticornis

Queensland Blue gum

STREET TREES



Agathis robusta Queensland Kauri Pine



Brachychiton populneus Kurrajong



Tristaniopsis laurina Luscious Water Gum

PROPOSED KALFRESH 6206 CUNNINGHAM HIGHWAY, KALBAR PLANTING IMAGES

JOB No. DWG No. ISSUE DRAWN BY CHECKED BY 23.274 003

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AMENDMENTS AS REQUIRED

AMENDMENTS AS REQUIRED DRAFT FOR REVIEW

REASON

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18/01/24

16/01/24

19/12/23 08/12/23

DIMENSIONS ARE TO BE VERIFIED ON SITE.

ISSUE DATE

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LEGEND

PROPERTY BOUNDARY
As taken from Survey drawings

FRONTAGE TYPES

CUNNINGHAM HIGHWAY FRONTAGE SCREEN LANDSCAPING Refer SRAIP Development Plan Area

OVERLAND FLOW PATH SCREEN LANDSCAPING

HAULAGE ROUTE FRONTAGE
AESTHETIC LANDSCAPING
Refer SRAIP Development Plan Area

PRIMARY FRONTAGE
AESTHETIC LANDSCAPING
Refer SRAIP Development Plan Area

ADDITIONAL TO SRAIP DEVELOPMENT PLAN

STREET LANDSCAPES - NEW ROADS
As per Scenic Rim Planning Scheme - PSP2
Landscape Design (SC6.2.2.2.1)

BUFFER LANDSCAPE - OVERLAND FLOW AREA
As per Scenic Rim Planning Scheme - PSP2
Landscape Design (SC6.2.2.2.1)

19/01/24 19/01/24 18/01/24 16/01/24 3 19/12/23 A 08/12/23

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GRAPHIC SCALE (m)



PROPOSED KALFRESH

6206 CUNNINGHAM HIGHWAY, KALBAR MASTER PLAN

JOB No. DWG No. ISSUE DRAWN BY CHECKED BY 23.274 100 F CP AG


CUNNINGHAM HIGHWAY FRONTAGE SCREEN LANDSCAPING - 4m MIN LANDSCAPE BUFFER PLANTING PLAN 1:100 @ A1

CUNNINGHAM HIGHWAY FRONTAGE

SCREEN LANDSCAPE - CUNNINGHAM HIGHWAY FRONTAGE: DESIGN INTENT

As per Scenic Rim Planning Scheme - Planning Scheme Policy 2: Landscape Design (SC6.2.2.2.3)

- is located between the proposed development (industrial tenancies) and the front boundary to Cunningham Highway
- incorporates a minimum width of 3 metres as per PSP 2: Landscape Design, however 4 metres proposed • reduces the visibility of the development to ensure it is not readily visible or discernible from the Cunningham Highway
- provides for screening specific to proposed buildings, parking, storage of industrial tenancies
- incorporates trees that at maturity are of a height that provides visual screening
- uses multiple layers of vegetation types including ground covers and shrubs, large shrubs, small trees, medium trees and large trees. In combination, the vegetation is to provide a continuous screen for the full height
- provides for trees at sufficient densities and numbers that ensures maximum reduction in visibility of the development or parts of the development required to be screened
- species informed by the Council's 'Preferred Landscape Species' within PSP 2: Landscape Design
- locally endemic species and/or native hybrids so as to be low maintenance, drought tolerant once established, fast growing to achieve rapid screening and storm/high winds resilient

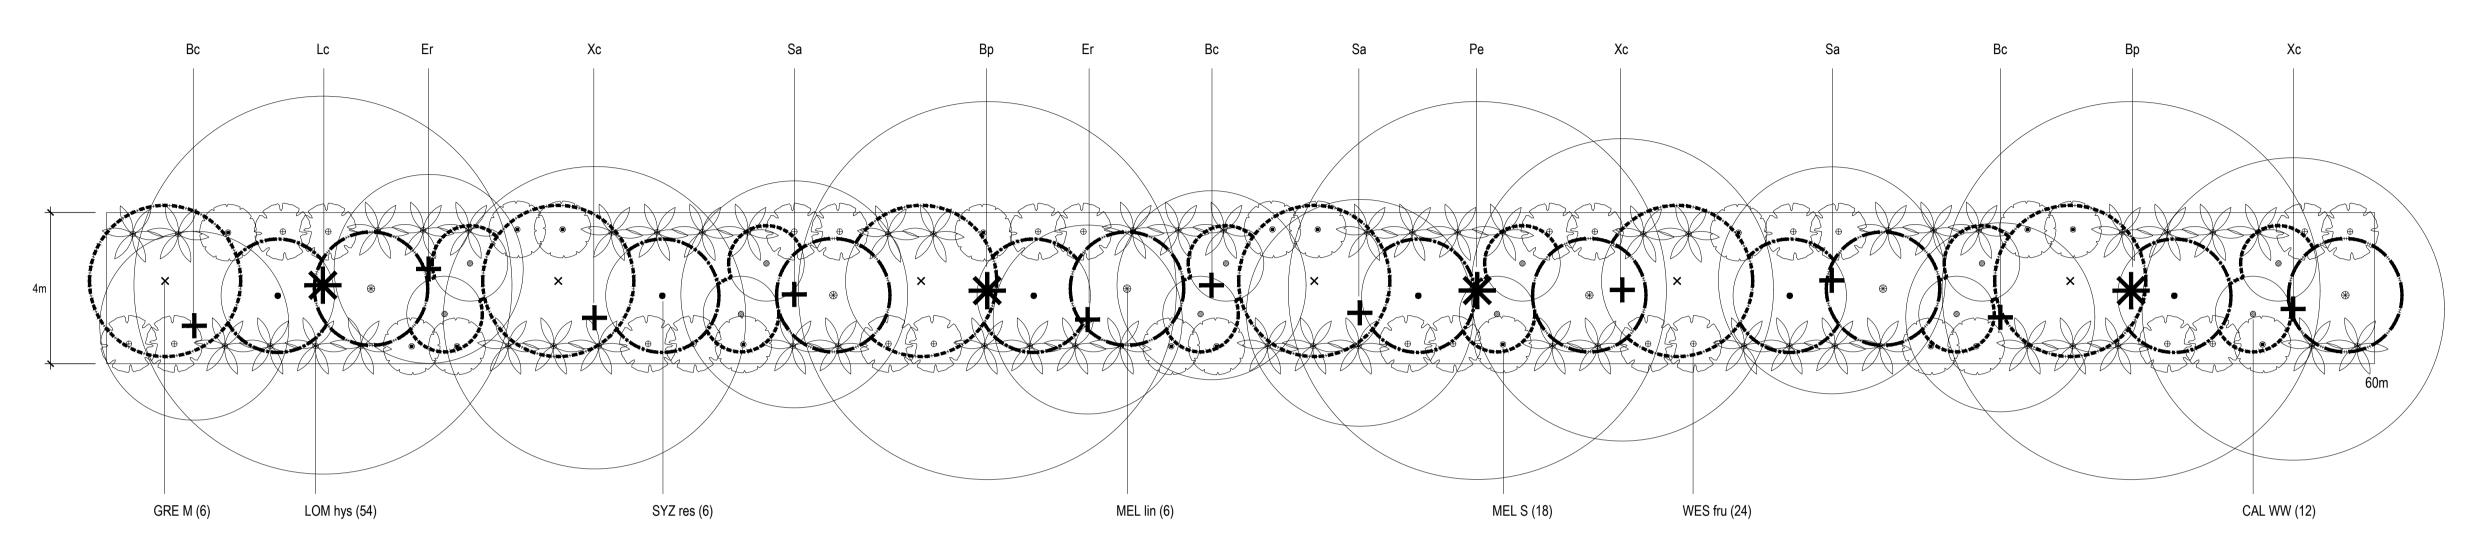


<1.5m GROUNDCOVERS TO SHRUBS



CUNNINGHAM HIGHWAY FRONTAGE

3 SCREEN LANDSCAPING - 4m MIN LANDSCAPE BUFFER ISOMETRIC SECTION NTS

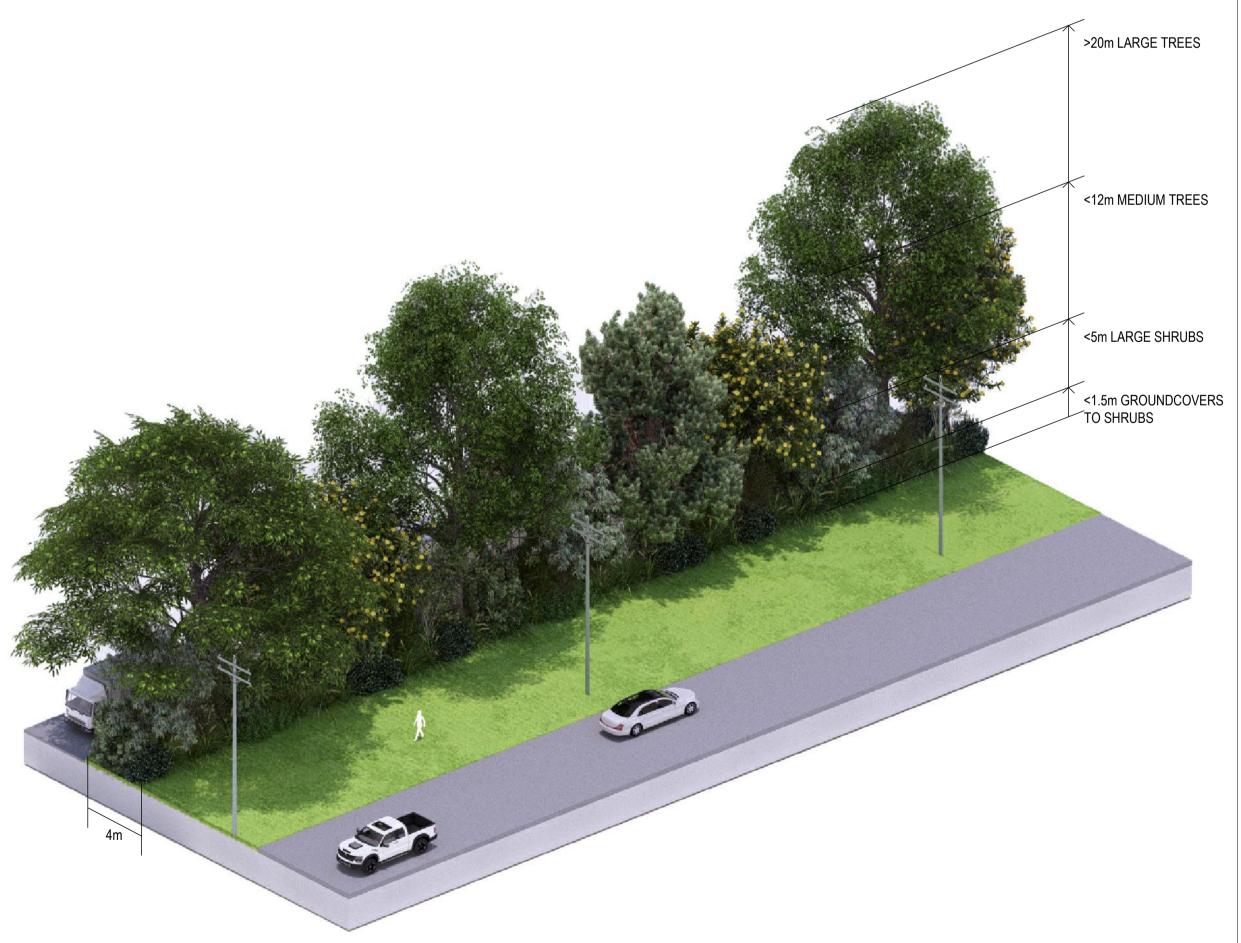




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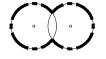
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LEGEND






Refer Planting Schedule

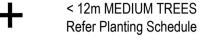

< 1.5m GROUNDCOVERS TO SHRUBS</p> Refer Planting Schedule

SHEET LOCATION PLAN

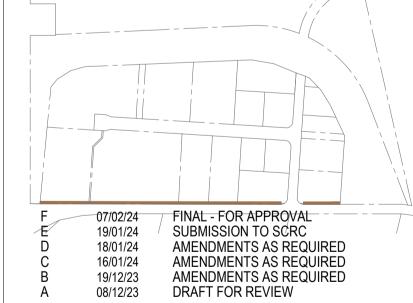

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PROPOSED KALFRESH 6206 CUNNINGHAM HIGHWAY, KALBAR

LANDSCAPE PLAN **CUNNINGHAM HIGHWAY FRONTAGE**

JOB No. DWG No. ISSUE DRAWN BY CHECKED BY 23.274 101 F CP AG

OVERLAND FLOW PATH SCREEN LANDSCAPING - 3m MIN LANDSCAPE BUFFER PLANTING PLAN 1:100 @ A1

GRE M (6) LOM hys (36) MEL S (9) WES fru (12) THE tri (9) SYZ res (6) CAL WA (12) MEL lin (6) CAL WW (12)






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LEGEND








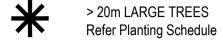

< 1.5m GROUNDCOVERS TO SHRUBS
Refer Planting Schedule



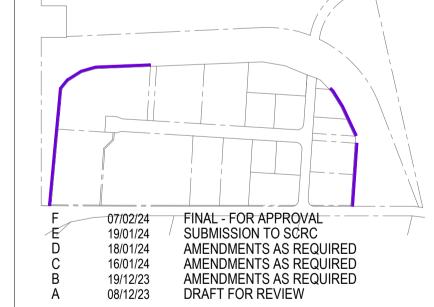

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6206 CUNNINGHAM HIGHWAY, KALBAR LANDSCAPE PLAN LOT 12 & 13 INTERFACE RURAL PRECINT

JOB No. DWG No. ISSUE DRAWN BY CHECKED BY 23.274 102 F CP AG

NOT FOR CONSTRUCTION



SCREEN LANDSCAPE - OVERLAND FLOW PATH: DESIGN INTENT

development required to be screened

rapid screening and storm/high winds resilient

• incorporates a minimum width of 3 metres as per PSP 2: Landscape Design

• incorporates trees that at maturity are of a height that provides visual screening

In combination, the vegetation is to provide a continuous screen for the full height

As per Scenic Rim Planning Scheme - Planning Scheme Policy 2: Landscape Design (SC6.2.2.2.3)

• provides for screening specific to proposed buildings, parking, storage of industrial tenancies

• species informed by the Council's 'Preferred Landscape Species' within PSP 2: Landscape Design

• is located between the proposed development (industrial tenancies) and the front boundary to Cunningham Highway


• reduces the visibility of the development to ensure it is not readily visible or discernible from the Cunningham Highway

• uses multiple layers of vegetation types including ground covers and shrubs, large shrubs, small trees, medium trees and large trees.

• provides for trees at sufficient densities and numbers that ensures maximum reduction in visibility of the development or parts of the

• locally endemic species and/or native hybrids so as to be low maintenance, drought tolerant once established, fast growing to achieve

HAULAGE ROUTE FRONTAGE AESTHETIC LANDSCAPING - 2m MIN LANDSCAPE BUFFER PLANTING PLAN 1:100 @ A1

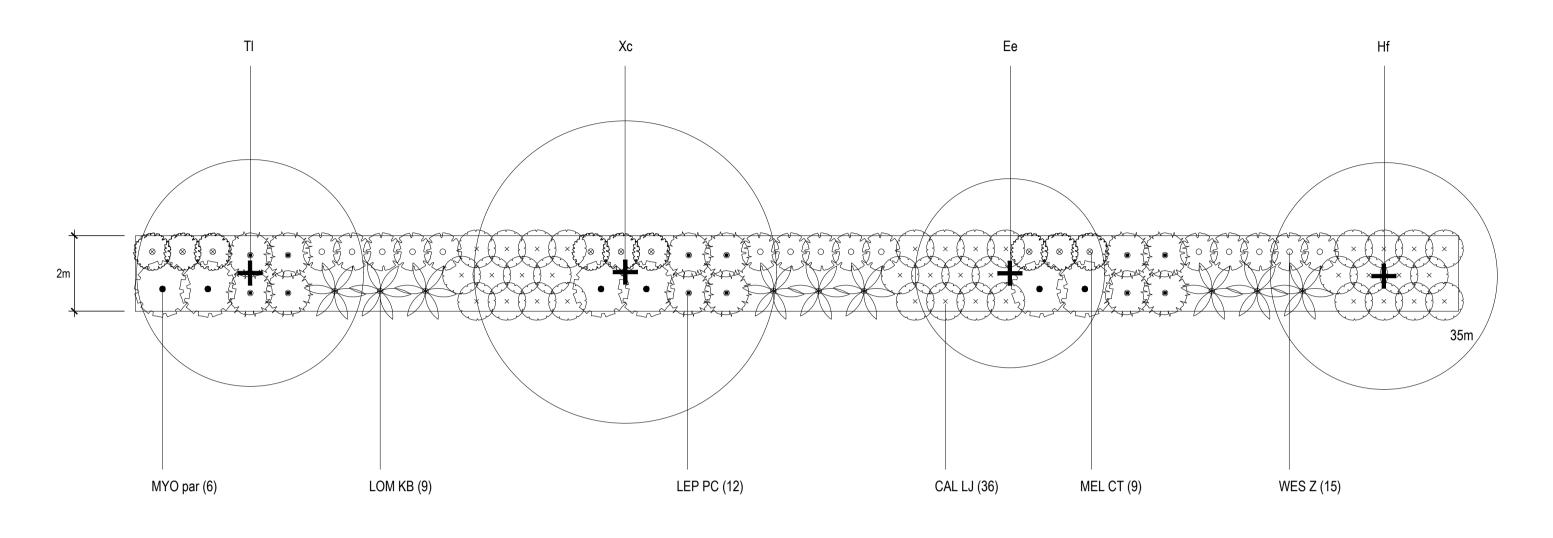

As per Scenic Rim Planning Scheme - Planning Scheme Policy 2: Landscape Design (SC6.2.2.2.1)


• is located between the proposed development (industrial tenancies) and new road

AESTHETIC LANDSCAPE - HAULAGE ROUTE FRONTAGE: DESIGN INTENT


- incorporates a minimum width of 2 metres
- reduces the visibility of structures by a minimum of 20% at maturity
- increases the aesthetic value of the site by provide trees to soften proposed buildings carparks, outdoor storage
- provide climatic amenity through shade to carparks where provided on the frontage
- to provide continuous landscaping excluding entry and exit points and required services (pad mount transformers, meters,
- provides landscape trees at regular intervals (approx 10m) supported by dense low level landscapes
- species informed by the Council's 'Preferred Landscape Species' within PSP 2: Landscape Design
- shown as a guide only and final design subject to individual lot design of subsequent lot holders, however this subsequent design is still yet to comply with the intent shown here, the above requirements as summarised from PSP2: Landscape Design

HAULAGE ROUTE FRONTAGE

2 AESTHETIC LANDSCAPING - 2m MIN LANDSCAPE BUFFER SECTION 1:75 @ A1

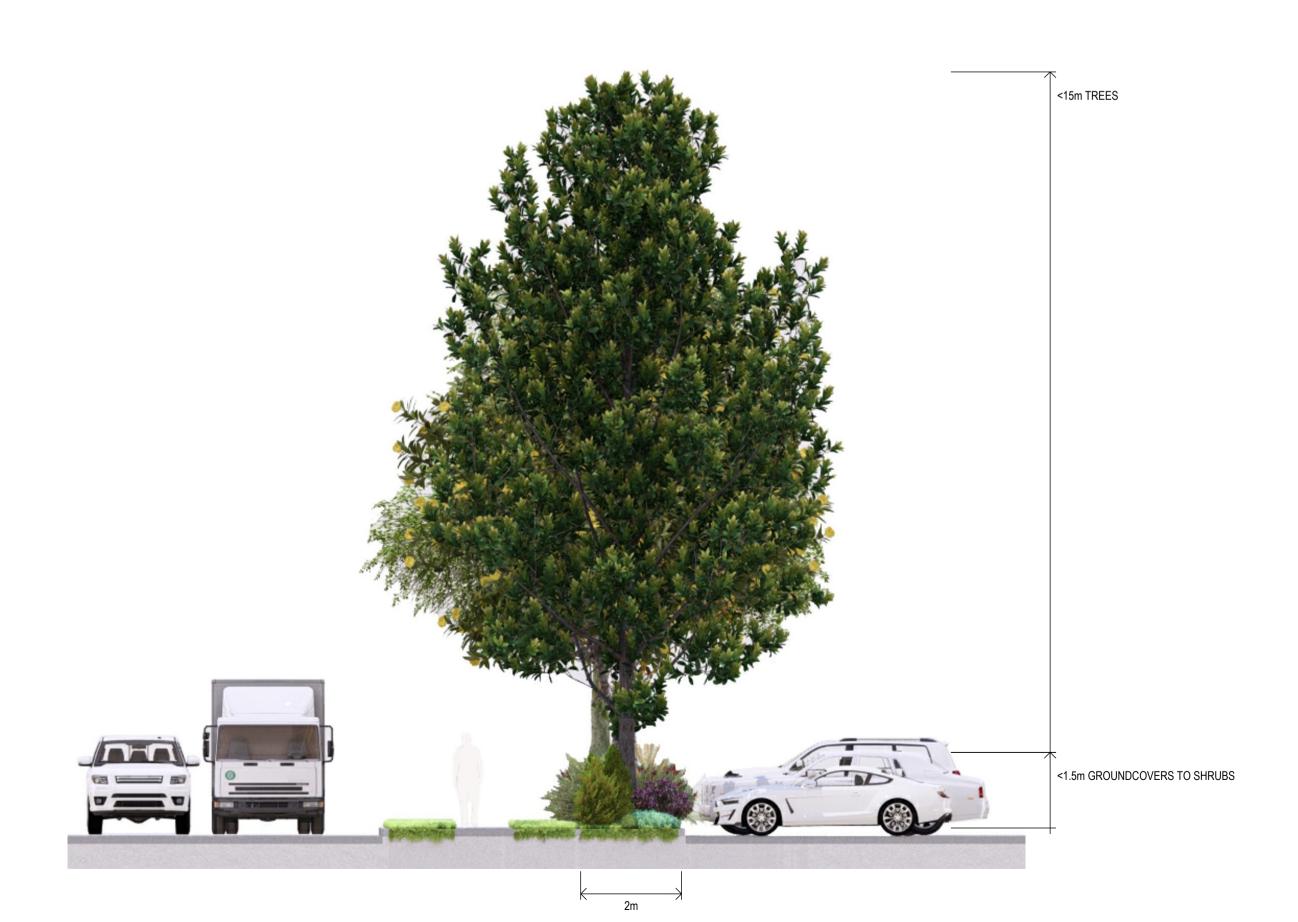

HAULAGE ROUTE FRONTAGE 3 AESTHETIC LANDSCAPING - 2m MIN LANDSCAPE BUFFER ISOMETRIC SECTION 1:100 @ A1

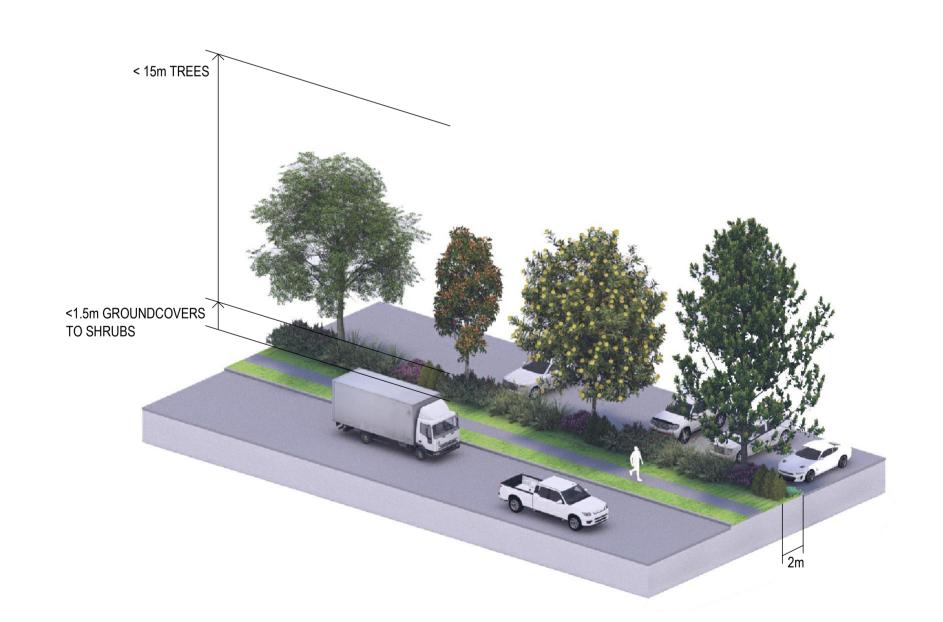




ANDREW GOLD LANDSCAPE ARCHITECTURE

PO BOX 5220 MT GRAVATT EAST QLD 4122


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LEGEND



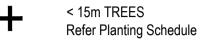




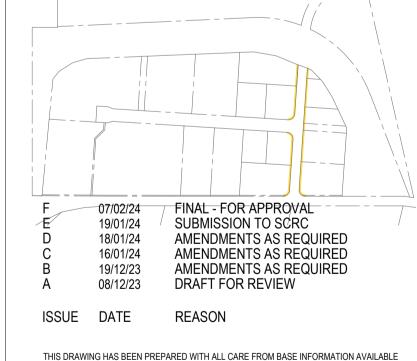

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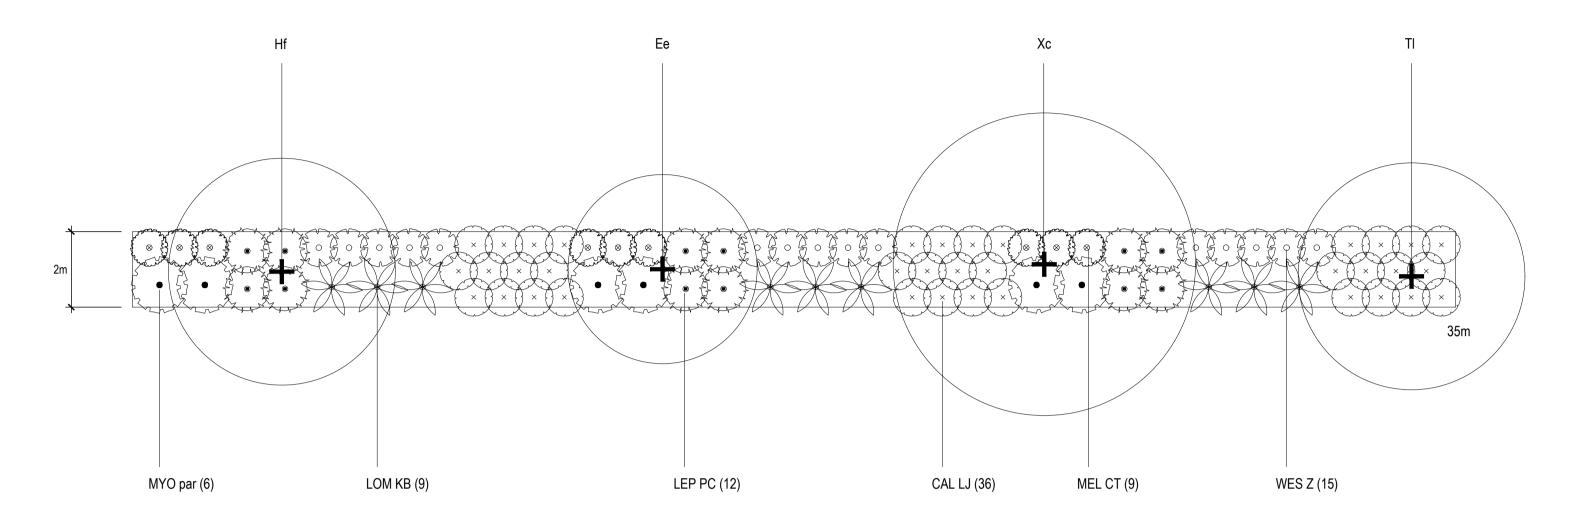
GRAPHIC SCALE (m)

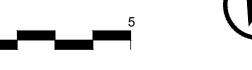

PROPOSED KALFRESH 6206 CUNNINGHAM HIGHWAY, KALBAR LANDSCAPE PLAN HAULAGE ROUTE FRONTAGE

JOB No. DWG No. ISSUE DRAWN BY CHECKED BY 23.274 **102** F CP

PRIMARY FRONTAGE AESTHETIC LANDSCAPING - 2m MIN LANDSCAPE BUFFER PLANTING PLAN 1:100 @ A1



As per Scenic Rim Planning Scheme - Planning Scheme Policy 2: Landscape Design (SC6.2.2.2.1)

- is located between the proposed development (industrial tenancies) and new road
- incorporates a minimum width of 2 metres
- reduces the visibility of structures by a minimum of 20% at maturity

AESTHETIC LANDSCAPE - PRIMARY FRONTAGE: DESIGN INTENT

- increases the aesthetic value of the site by provide trees to soften proposed buildings carparks, outdoor storage
- provide climatic amenity through shade to carparks where provided on the frontage
- to provide continuous landscaping excluding entry and exit points and required services (pad mount transformers, meters, boosters etc)
- provides landscape trees at regular intervals (approx 10m) supported by dense low level landscapes
- species informed by the Council's 'Preferred Landscape Species' within PSP 2: Landscape Design
- shown as a guide only and final design subject to individual lot design of subsequent lot holders, however this subsequent design is still yet to comply with the intent shown here, the above requirements as summarised from PSP2: Landscape Design

PRIMARY FRONTAGE

AESTHETIC LANDSCAPING - 2m MIN LANDSCAPE BUFFER


SECTION 1:75 @ A1

*15m GROUNDCOVERS TO SHRUSS

PRIMARY FRONTAGE

AESTHETIC LANDSCAPING - 2m MIN LANDSCAPE BUFFER

ISOMETRIC SECTION NTS

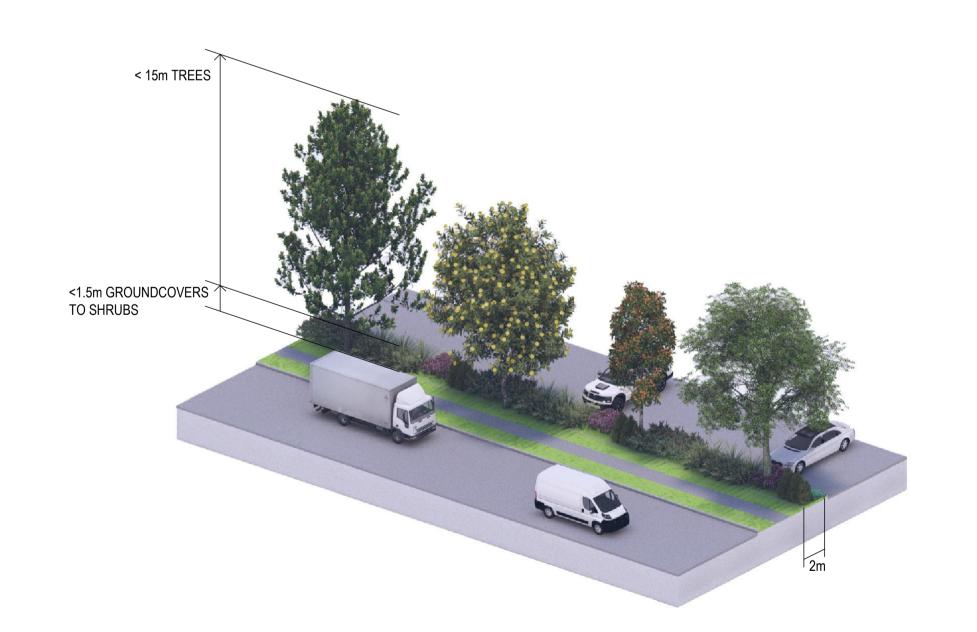



ANDREW GOLD LANDSCAPE ARCHITECTURE


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LEGEND







SUE DATE REASO
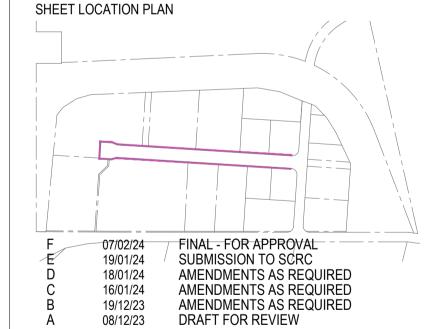
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GRAPHIC SC

1:100@ A1





LANDSCAPE PLAN PRIMARY FRONTAGE

JOB No. DWG No. ISSUE DRAWN BY CHECKED BY 23.274 103 F CP AG

CUNNINGHAM HIGHWAY FRONTAGE SCREEN LANDSCAPING - 4m MIN LANDSCAPE BUFFER PERSPECTIVE NTS



HAULAGE ROUTE FRONTAGE

AESTHETIC LANDSCAPING - 2m MIN LANDSCAPE BUFFER
PERSPECTIVE NTS



OVERLAND FLOW PATH SCREEN LANDSCAPING - 3m MIN LANDSCAPE BUFFER PERSPECTIVE NTS



PRIMARY FRONTAGE

AESTHETIC LANDSCAPING - 2m MIN LANDSCAPE BUFFER
PERSPECTIVE NTS



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F 07/02/24 E 19/01/24 D 18/01/24 C 16/01/24 B 19/12/23 A 08/12/23 FINAL - FOR APPROVAL SUBMISSION TO SCRC AMENDMENTS AS REQUIRED AMENDMENTS AS REQUIRED AMENDMENTS AS REQUIRED DRAFT FOR REVIEW

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PROPOSED KALFRESH
6206 CUNNINGHAM HIGHWAY,
KALBAR
PERSPECTIVES
FRONTAGES

JOB No. DWG No. ISSUE DRAWN BY CHECKED BY 23.274 200 F CP AG



- located on the over land flow located between the industry precinct and the rural precinct
- reduces the visibility of the development
 species as recommended in the Ecological Assessment Report
- very large, fast growing endemic native species
- 30 trees to be planted in overland flow area



SPECIAL NOTE: TREE PLANTING IN OVERLAND FLOW AREA Planting as shown is preliminary and indicative only and final locations may change subject to subsequent design resolution, engineering advice, subsequent Council approvals.



ANDREW GOLD LANDSCAPE ARCHITECTURE

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LEGEND

PROPOSED TURFED AREAS Refer Landscape Notes and Detail

> As taken from Survey drawings PROPOSED CONTOURS

PROPERTY BOUNDARY

Refer Engineering drawings

PROPOSED BUFFER TREES
Refer Planting Schedule

18/01/24 16/01/24 19/12/23 08/12/23

FINAL - FOR APPROVAL SUBMISSION TO SCRC AMENDMENTS AS REQUIRED AMENDMENTS AS REQUIRED AMENDMENTS AS REQUIRED DRAFT FOR REVIEW

ISSUE DATE REASON


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GRAPHIC SCALE (m)

PROPOSED KALFRESH 6206 CUNNINGHAM HIGHWAY, KALBAR

BUFFER LANDSCAPE PLAN

JOB No. DWG No. ISSUE DRAWN BY CHECKED BY 23.274 **300** F CP



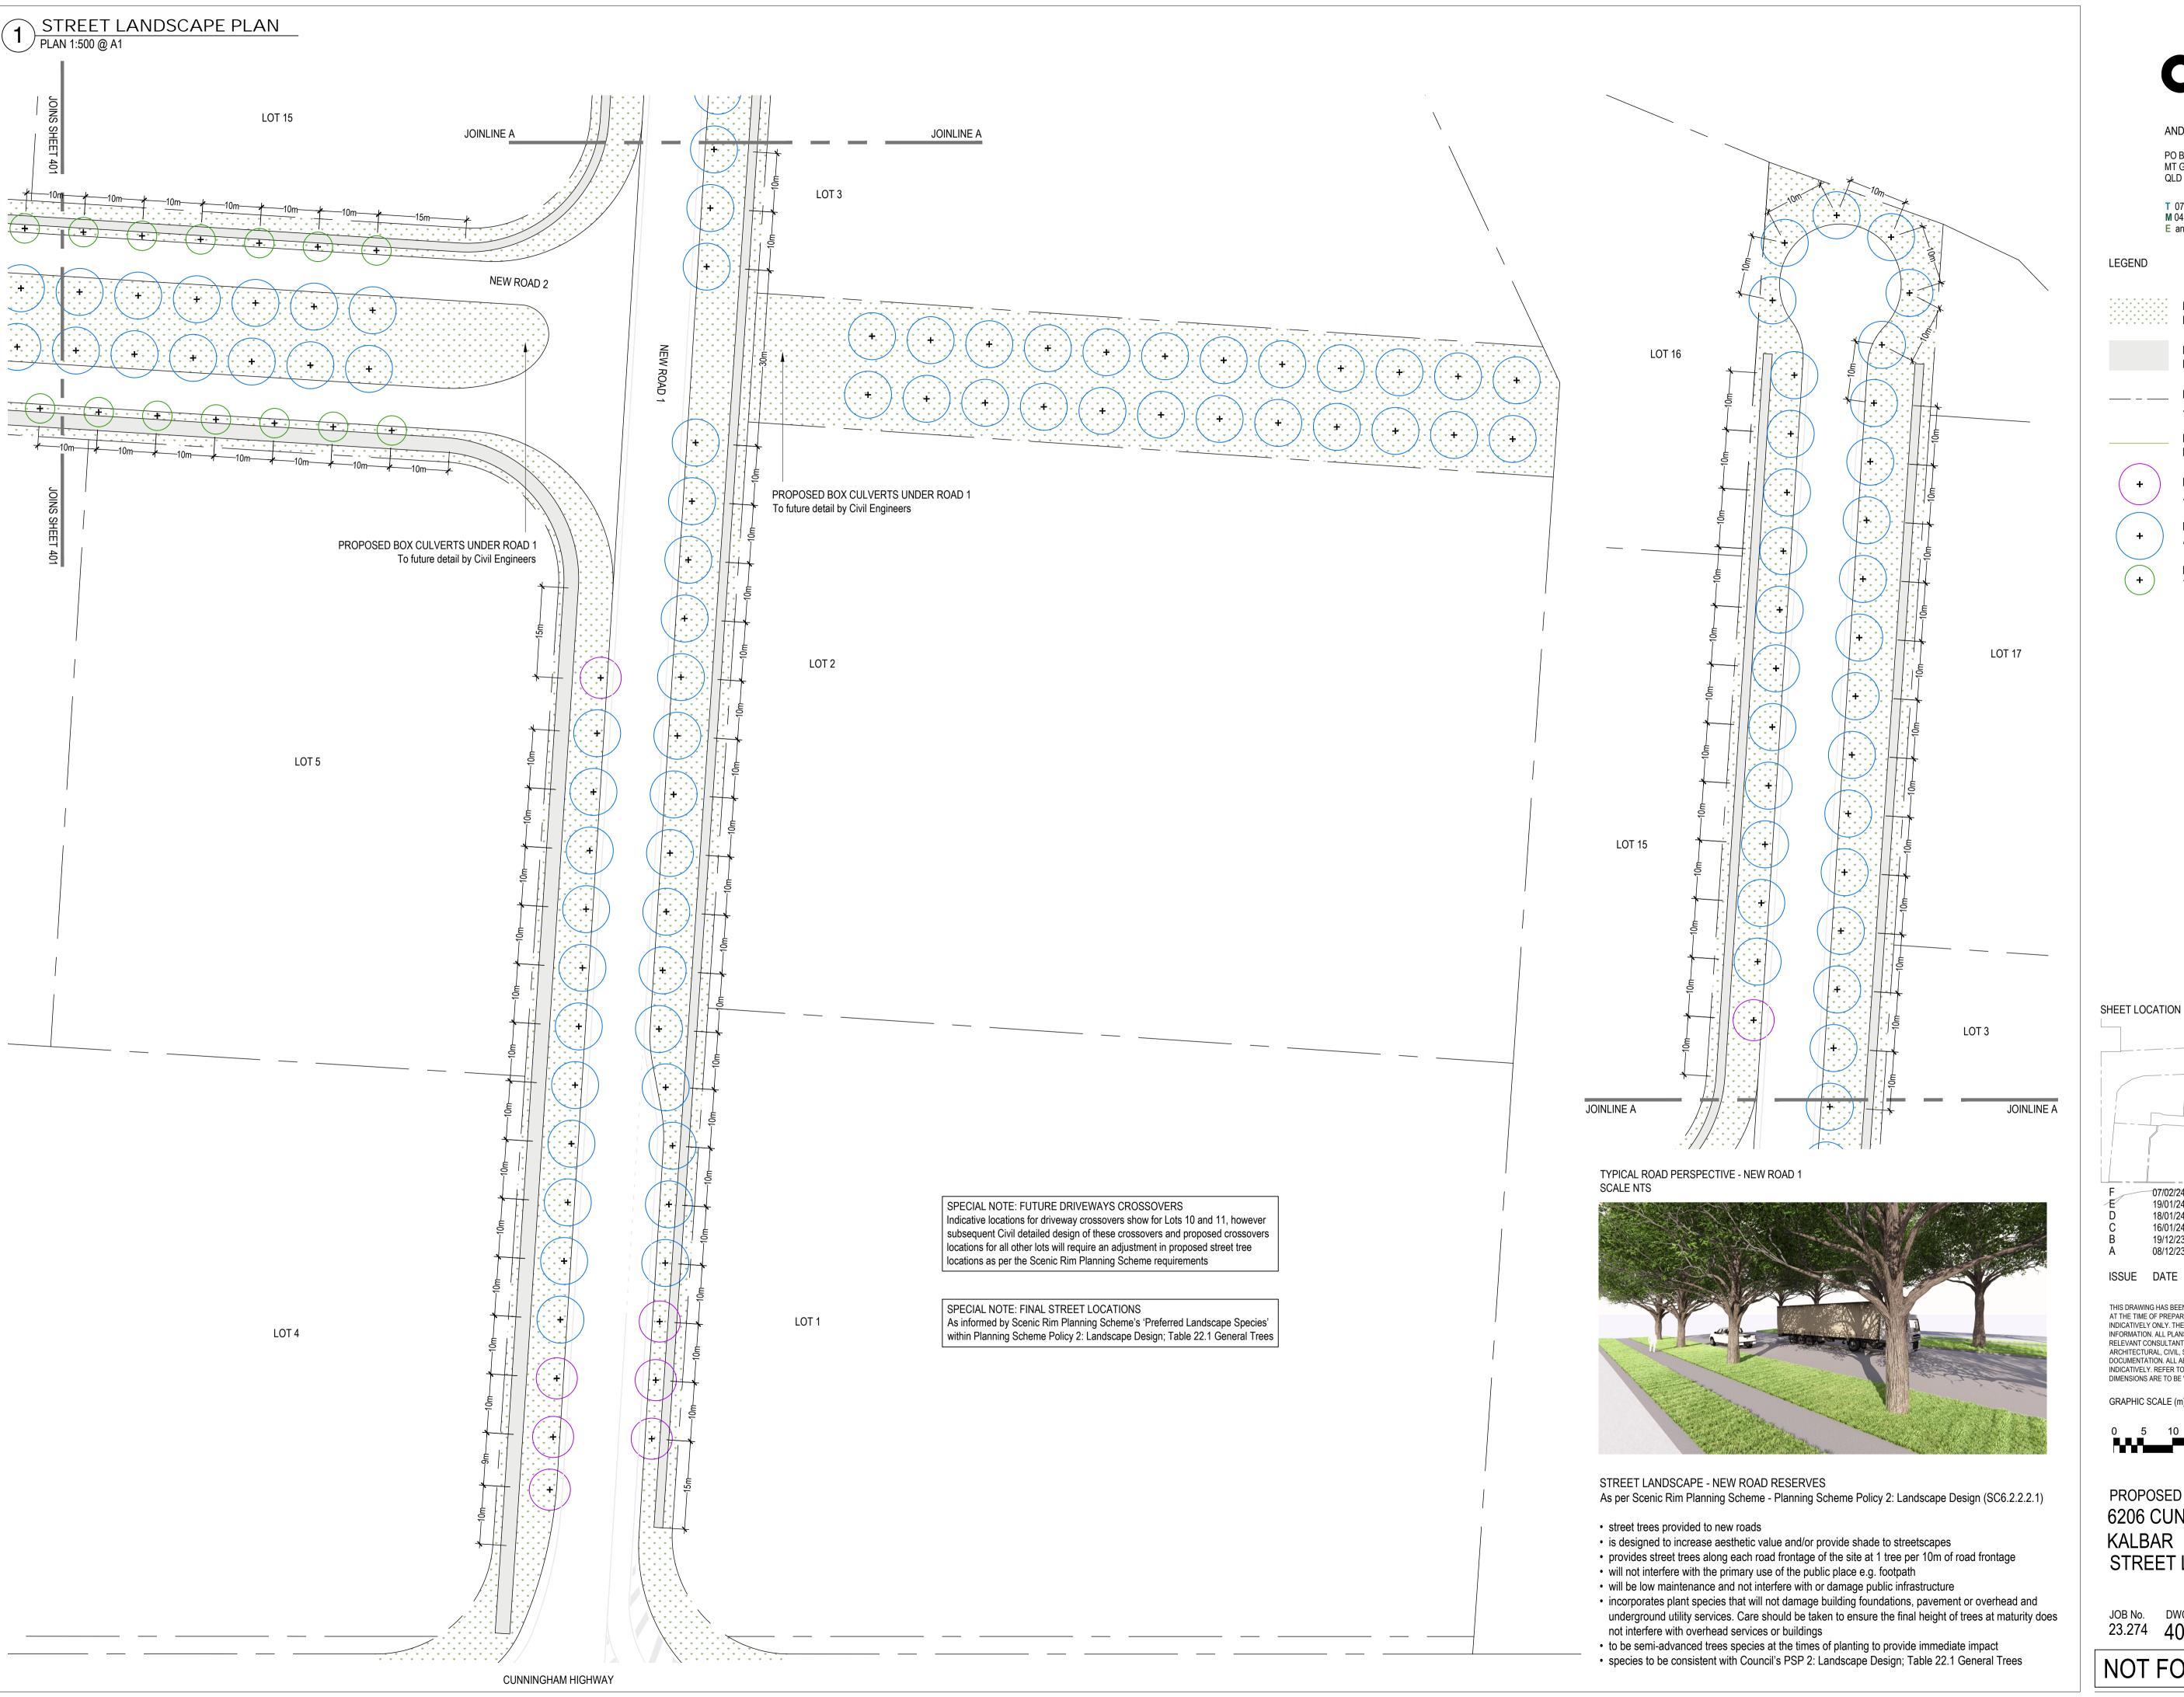

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> PROPOSED TURFED AREAS Refer Landscape Notes and Detail

PROPOSED HARDSTAND Refer Engineeering drawings

PROPERTY BOUNDARY As taken from Survey drawings

PROPOSED CONTOURS Refer Engineering drawings


PROPOSED STREET TREE Agathis robusta - Refer Planting Schedule

PROPOSED STREET TREE Brachychiton populneus - Refer Planting Schedule

PROPOSED STREET TREES

Tristaniopsis laurina Luscious - Refer Planting Schedule

SHEET LOCATION PLAN

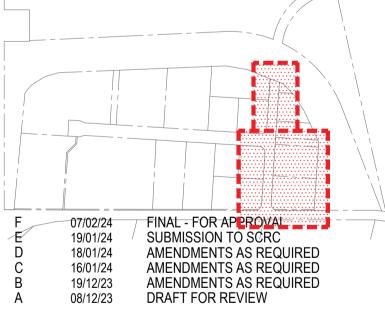


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GRAPHIC SCALE (m)



PROPOSED KALFRESH 6206 CUNNINGHAM HIGHWAY, KALBAR STREET LANDSCAPE PLAN

JOB No. DWG No. ISSUE DRAWN BY CHECKED BY 23.274 **400** F



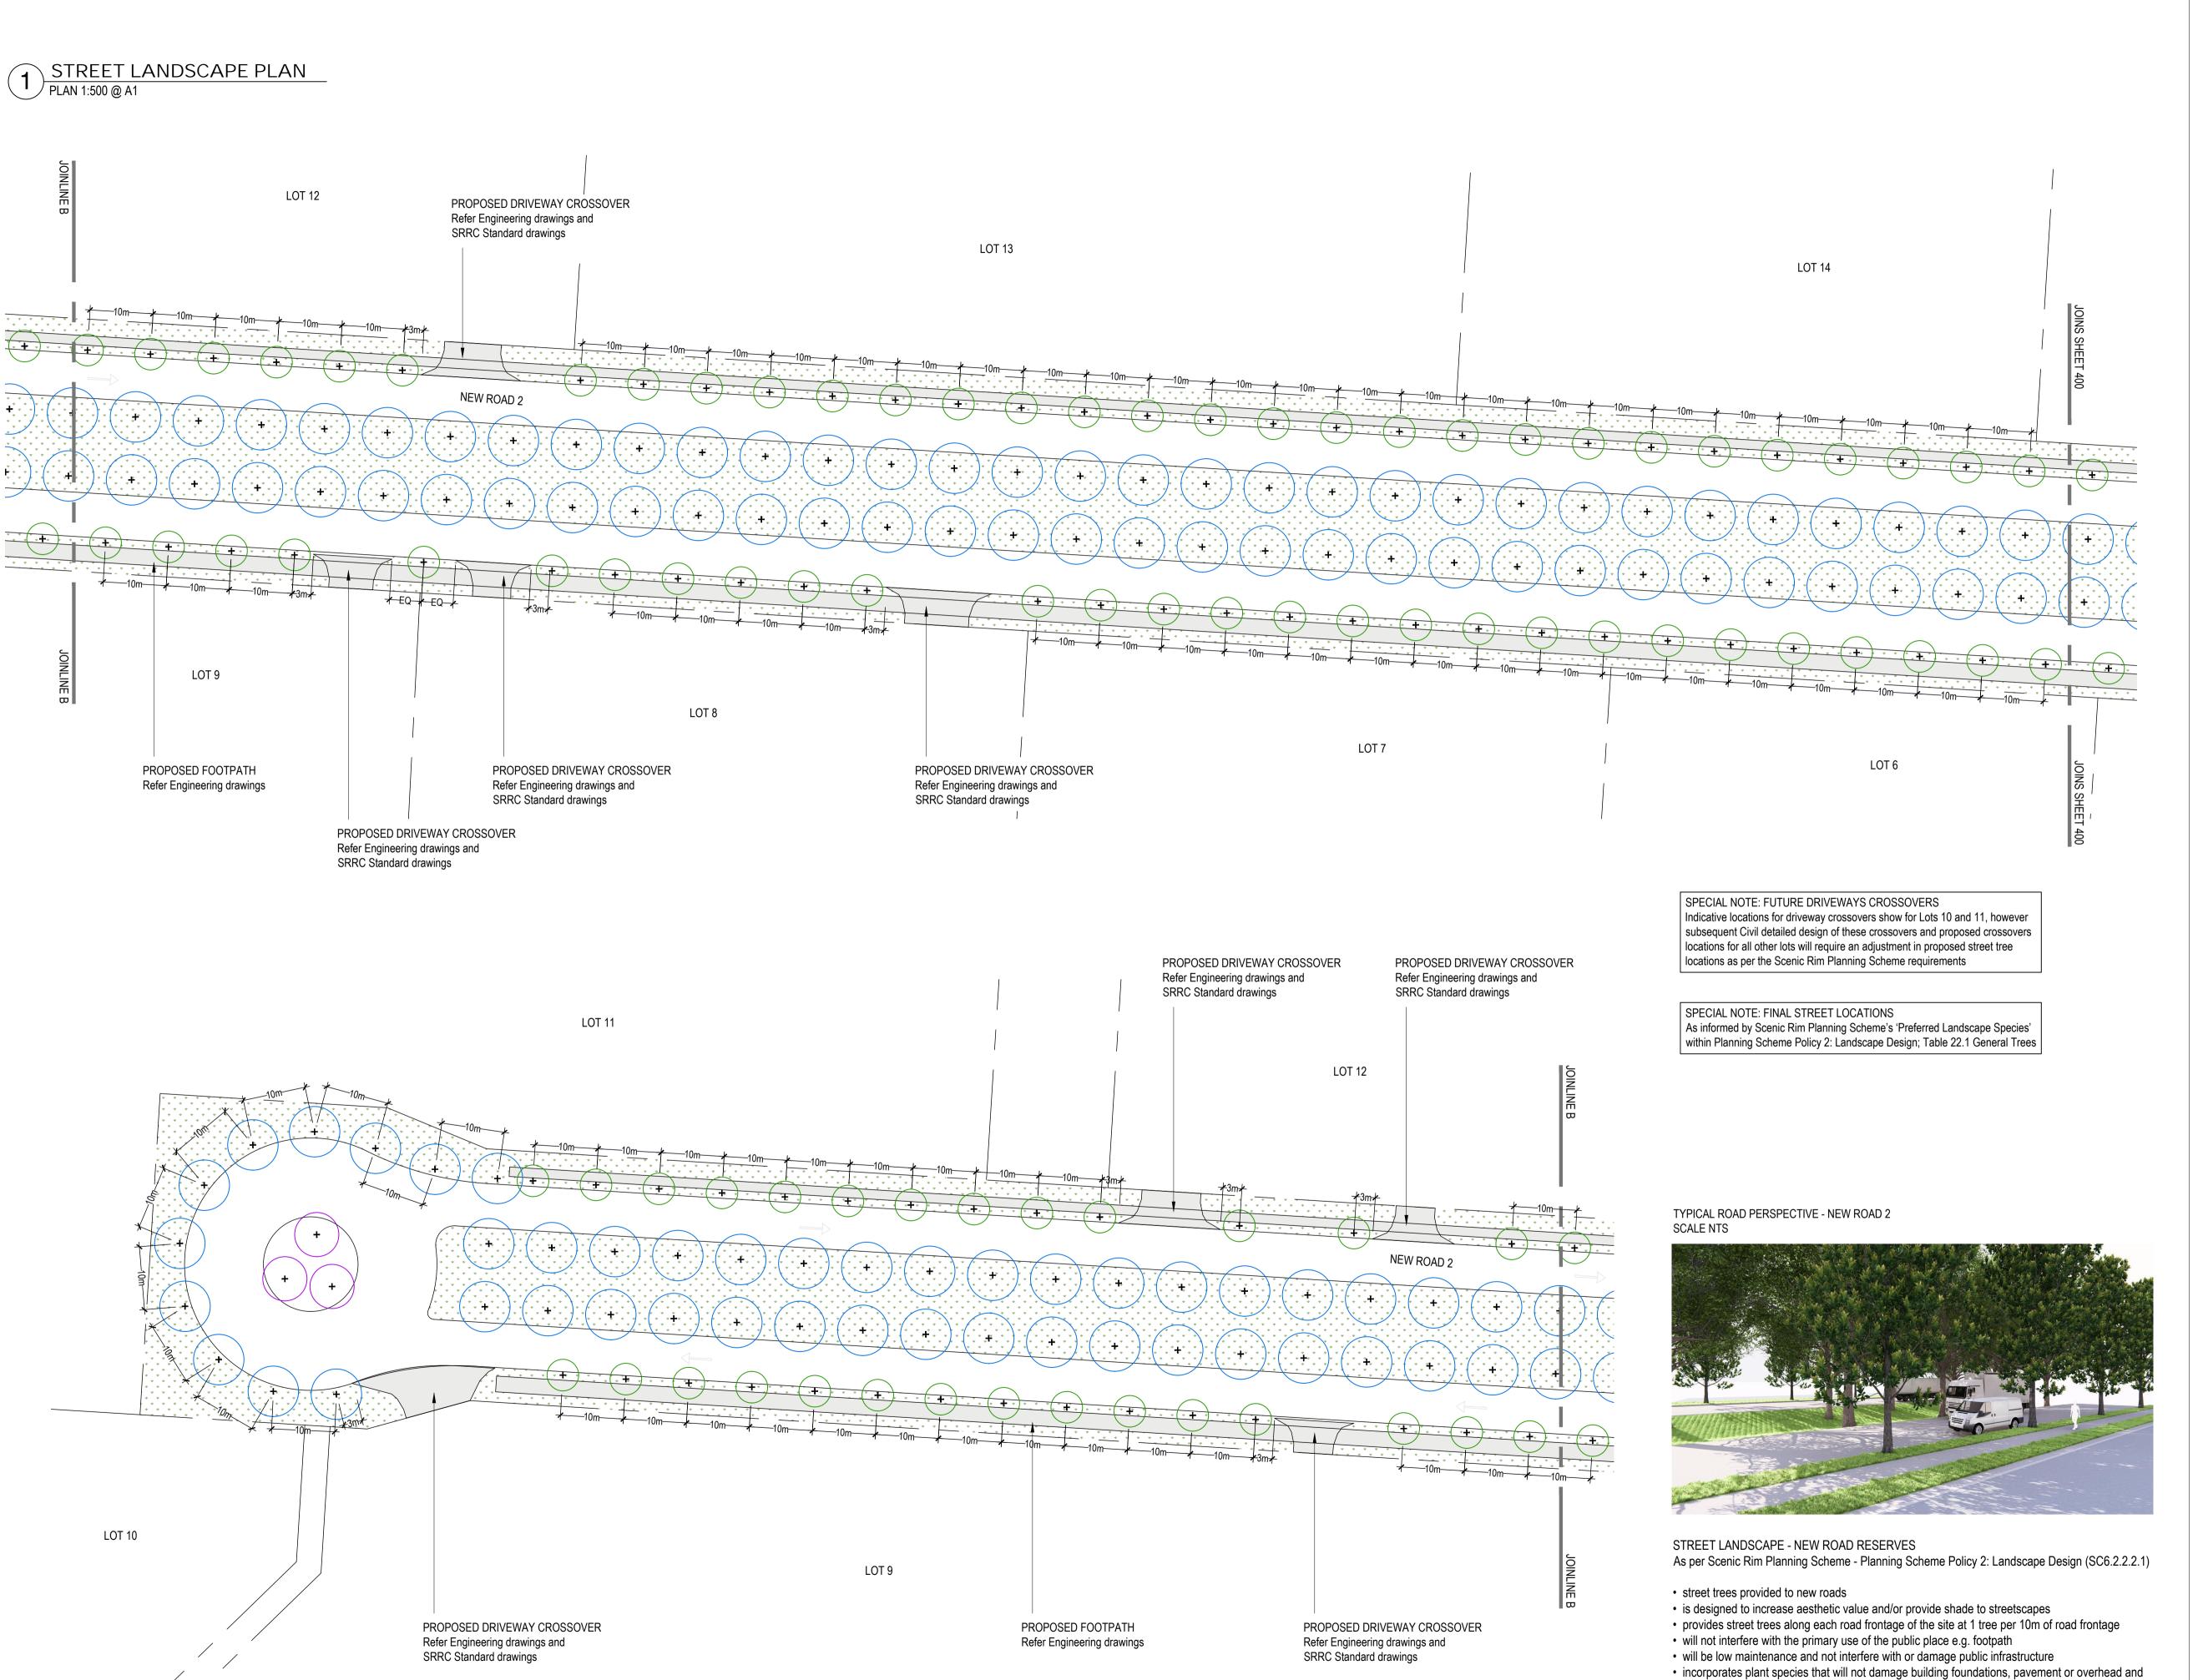

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LEGEND

PROPOSED TURFED AREAS Refer Landscape Notes and Detail

> PROPOSED HARDSTAND Refer Engineeering drawings

PROPERTY BOUNDARY As taken from Survey drawings


PROPOSED CONTOURS Refer Engineering drawings

PROPOSED STREET TREES Agathis robusta - Refer Planting Schedule

PROPOSED STREET TREES Brachychiton populneus - Refer Planting Schedule

PROPOSED STREET TREES Tristaniopsis laurina Luscious - Refer Planting Schedule


SHEET LOCATION PLAN

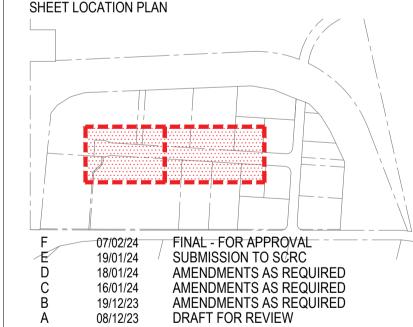

REASON ISSUE DATE

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GRAPHIC SCALE (m)

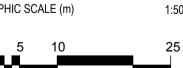

PROPOSED KALFRESH 6206 CUNNINGHAM HIGHWAY, KALBAR

STREET LANDSCAPE PLAN

23.274 **401** F

underground utility services. Care should be taken to ensure the final height of trees at maturity does

• to be semi-advanced trees species at the times of planting to provide immediate impact • species to be consistent with Council's PSP 2: Landscape Design; Table 22.1 General Trees

not interfere with overhead services or buildings

NOT FOR CONSTRUCTION

JOB No. DWG No. ISSUE DRAWN BY CHECKED BY



2 TYPICAL ROAD CROSS SECTION - NEW ROAD 2 SCALE 1:100 @ A1





ANDREW GOLD LANDSCAPE ARCHITECTURE

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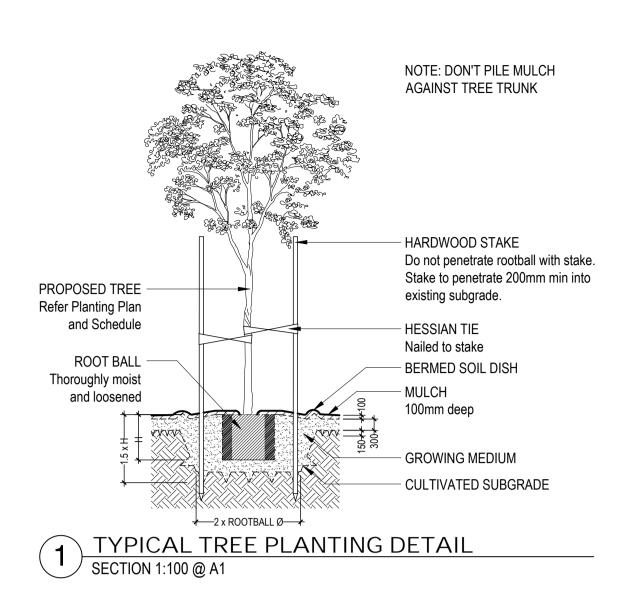
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GRAPHIC SCALE (m)



PROPOSED KALFRESH 6206 CUNNINGHAM HIGHWAY, KALBAR STREET LANDSCAPE TYPICAL SECTIONS

JOB No. DWG No. ISSUE DRAWN BY CHECKED BY 23.274 402 F CP AG



1200mm MULCH CIRCLE


Refer Specification Notes


Refer Specification Notes and Detail

SPADE CUT EDGE


Refer Detail

→ PROPOSED TURF

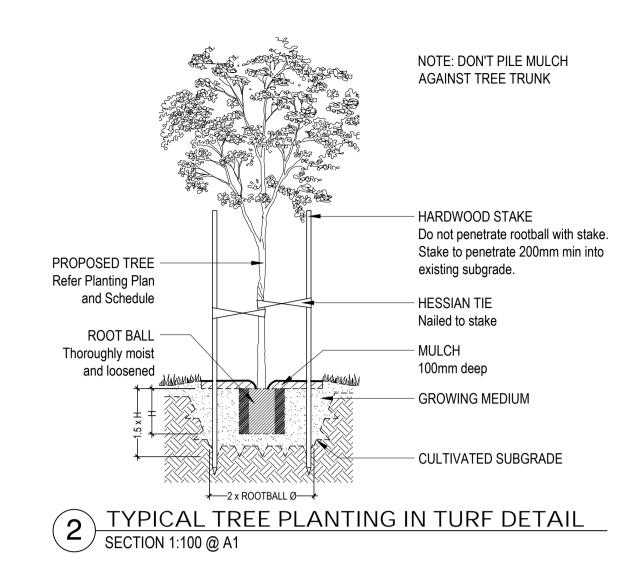


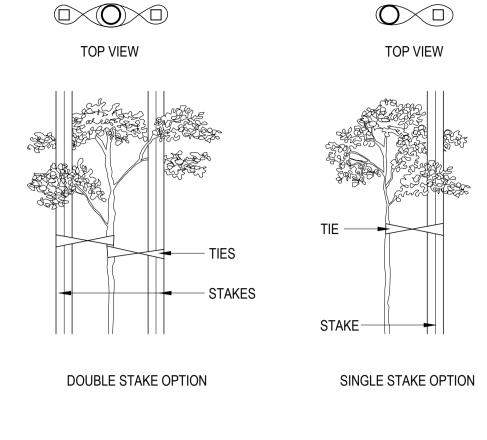


3 TYPICAL TREE STAKING DETAIL SECTION NOT TO SCALE

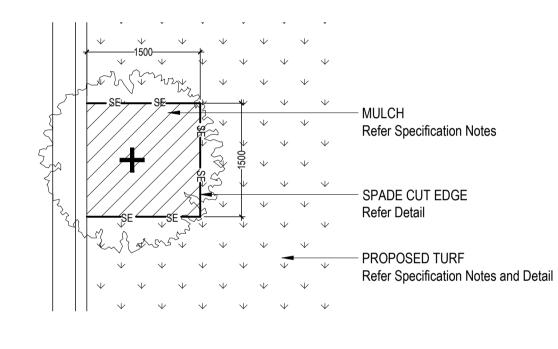

5 STREET TREES IN TURF DETAIL
SECTION 1:50 @ A1

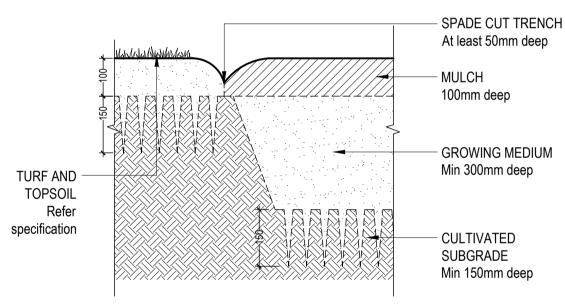


6 SPADE CUT EDGE DETAIL SECTION 1:10 @ A1

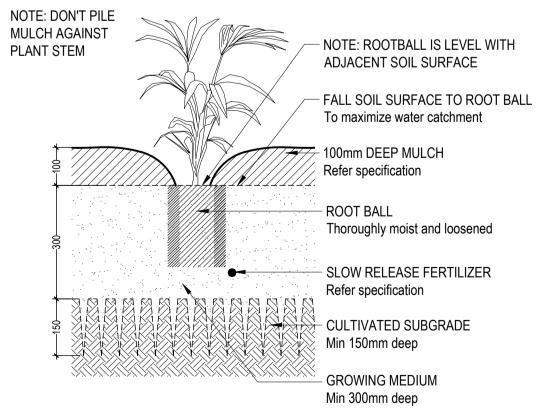


TREES IN TURF DETAIL




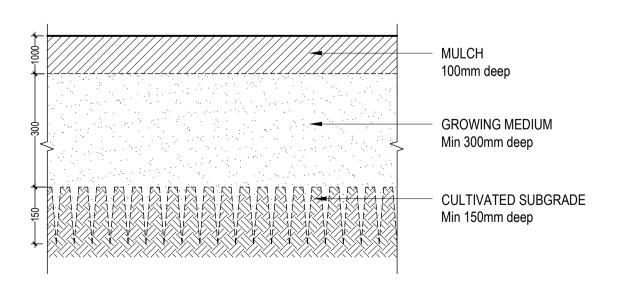

8 TYPICAL GARDEN BED DETAIL SECTION 1:10 @ A1

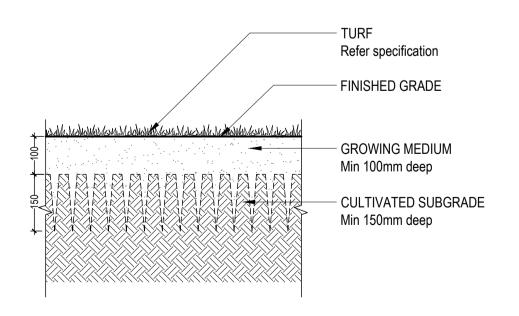

9 TYPICAL TURF PLANTING DETAIL
SECTION 1:10 @ A1

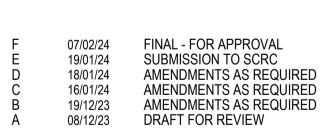

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PROPOSED KALFRESH
6206 CUNNINGHAM HIGHWAY,
KALBAR
LANDSCAPE DETAILS

JOB No. DWG No. ISSUE DRAWN BY CHECKED BY 23.274 500 F CP AG